

PROFILE
VERT. 1"=4'
HOR. 1"=40'

NOTE: WATER MAIN NOT SHOWN



The plan of development for the property as depicted hereon was approved by a majority of the members of the Town of East Longmeadow Planning Board at a meeting held on 12-16-19, and the conditions of Site Plan Approval have been satisfied or arrangements have been made to ensure the completion of any outstanding or incomplete

Chairman

Vice Chair

Clerk

Clerk

Clerk

Coorditions.

C

03-06-2019 Date 0

ISSUED TO PLANNING BOARD EDM 10/27/18
ISSUE/DESCRIPTION BY DATE

DESCRIPTION BY DATE

DESCRIPTION BY DESCRIPTION OF THE SOLE PROPERTY OF

**GRAPHIC SCALE** 

SCALE IN FEET

SCALE IN FEET

LEGEND

\_\_\_\_\_225 \_\_\_\_ EXISTING 5 FT. CONTOURS

\_\_\_\_\_ EXISTING 1 FT. CONTOURS

----- EXISTING EDGE OF PAVEMENT

· · · · · · · · · · · · · · 100 FT. BUFFER

--- WETLAND BOUNDARY

SITE PROPERTY BOUNDARY

EXISTING DRAINAGE LINE

- EXISTING SANITARY SEWER

EXISTING GAS LINE

**EXISTING WATER LINE** 

EXISTING CATCH BASIN

EXISTING UTILITY POLE

EXISTING WATER VALVE

PROPOSED SPOT GRADE

---- PROPOSED EDGE OF PAVEMENT

PROPOSED CONTOUR

PROPOSED STORM DRAIN LINE

- PROPOSED WATER LINE

PROPOSED SANITARY SEWER

PROPOSED CATCH BASIN B
5

PROPOSED MANHOLE  $\begin{pmatrix} A \\ 5 \end{pmatrix} \begin{pmatrix} G \\ 5 \end{pmatrix}$ 

PROPOSED HYDRANT (1)

PROPOSED WATER VALVE

PROPOSED LIGHT POLE (5)

PROPOSED CURB

EXISTING HYDRANT

EXISTING DRAIN MANHOLE

EXISTING SANITARY MANHOLE


EXISTING CURB


UNLESS SPECIFICALLY STATED BY WRITTEN AGREEMENT, THIS DRAWING IS THE SOLE PROPERTY OF GZA GEOENVIRONMENTAL, INC. (GZA). THE INFORMATION SHOWN ON THE DRAWING IS SOLELY FOR USE BY GZA'S CLIENT OR THE CLIENT'S DESIGNATED REPRESENTATIVE FOR THE SPECIFIC PROJECT AND LOCATION IDENTIFIED ON THE DRAWING. THE DRAWING SHALL NOT BE TRANSFERRED, REUSED, COPIED, OR ALTERED IN ANY MANNER FOR USE AT ANY OTHER LOCATION OR FOR ANY OTHER PURPOSE WITHOUT THE PRIOR WRITTEN CONSENT OF GZA. ANY TRANSFER, REUSE, OR MODIFICATION TO THE DRAWING BY THE CLIENT OR OTHERS, WITHOUT THE PRIOR WRITTEN EXPRESS CONSENT OF GZA, WILL BE AT THE USER'S SOLE RISK AND WITHOUT ANY RISK OR LIABILITY TO GZA.


PHASE V-B
THE FIELDS AT CHESTNUT
CHESTNUT STREET EAST LONGMEADOW, MA

## CLOVER LANE PLAN & PROFILE STA 10+00 TO 18+50

	oEnvironmental of NY eers and Scientists www.gza.com	PREPARED FOR: DAN ROULIER & ASSOCIATES 11 SOUTH ROAD SOMERS, CT 06071			
PROJ MGR: TEJ	REVIEWED BY: TEJ	CHECKED BY: TEJ	DRAWING		
DESIGNED BY: TEJ	DRAWN BY: EDM	SCALE: 1"=40'			
DATE: OCTOBER 2018	PROJECT NO. 05-0306	REVISION NO. 1	SHEET NO. 2 OF 5		

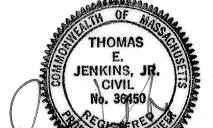

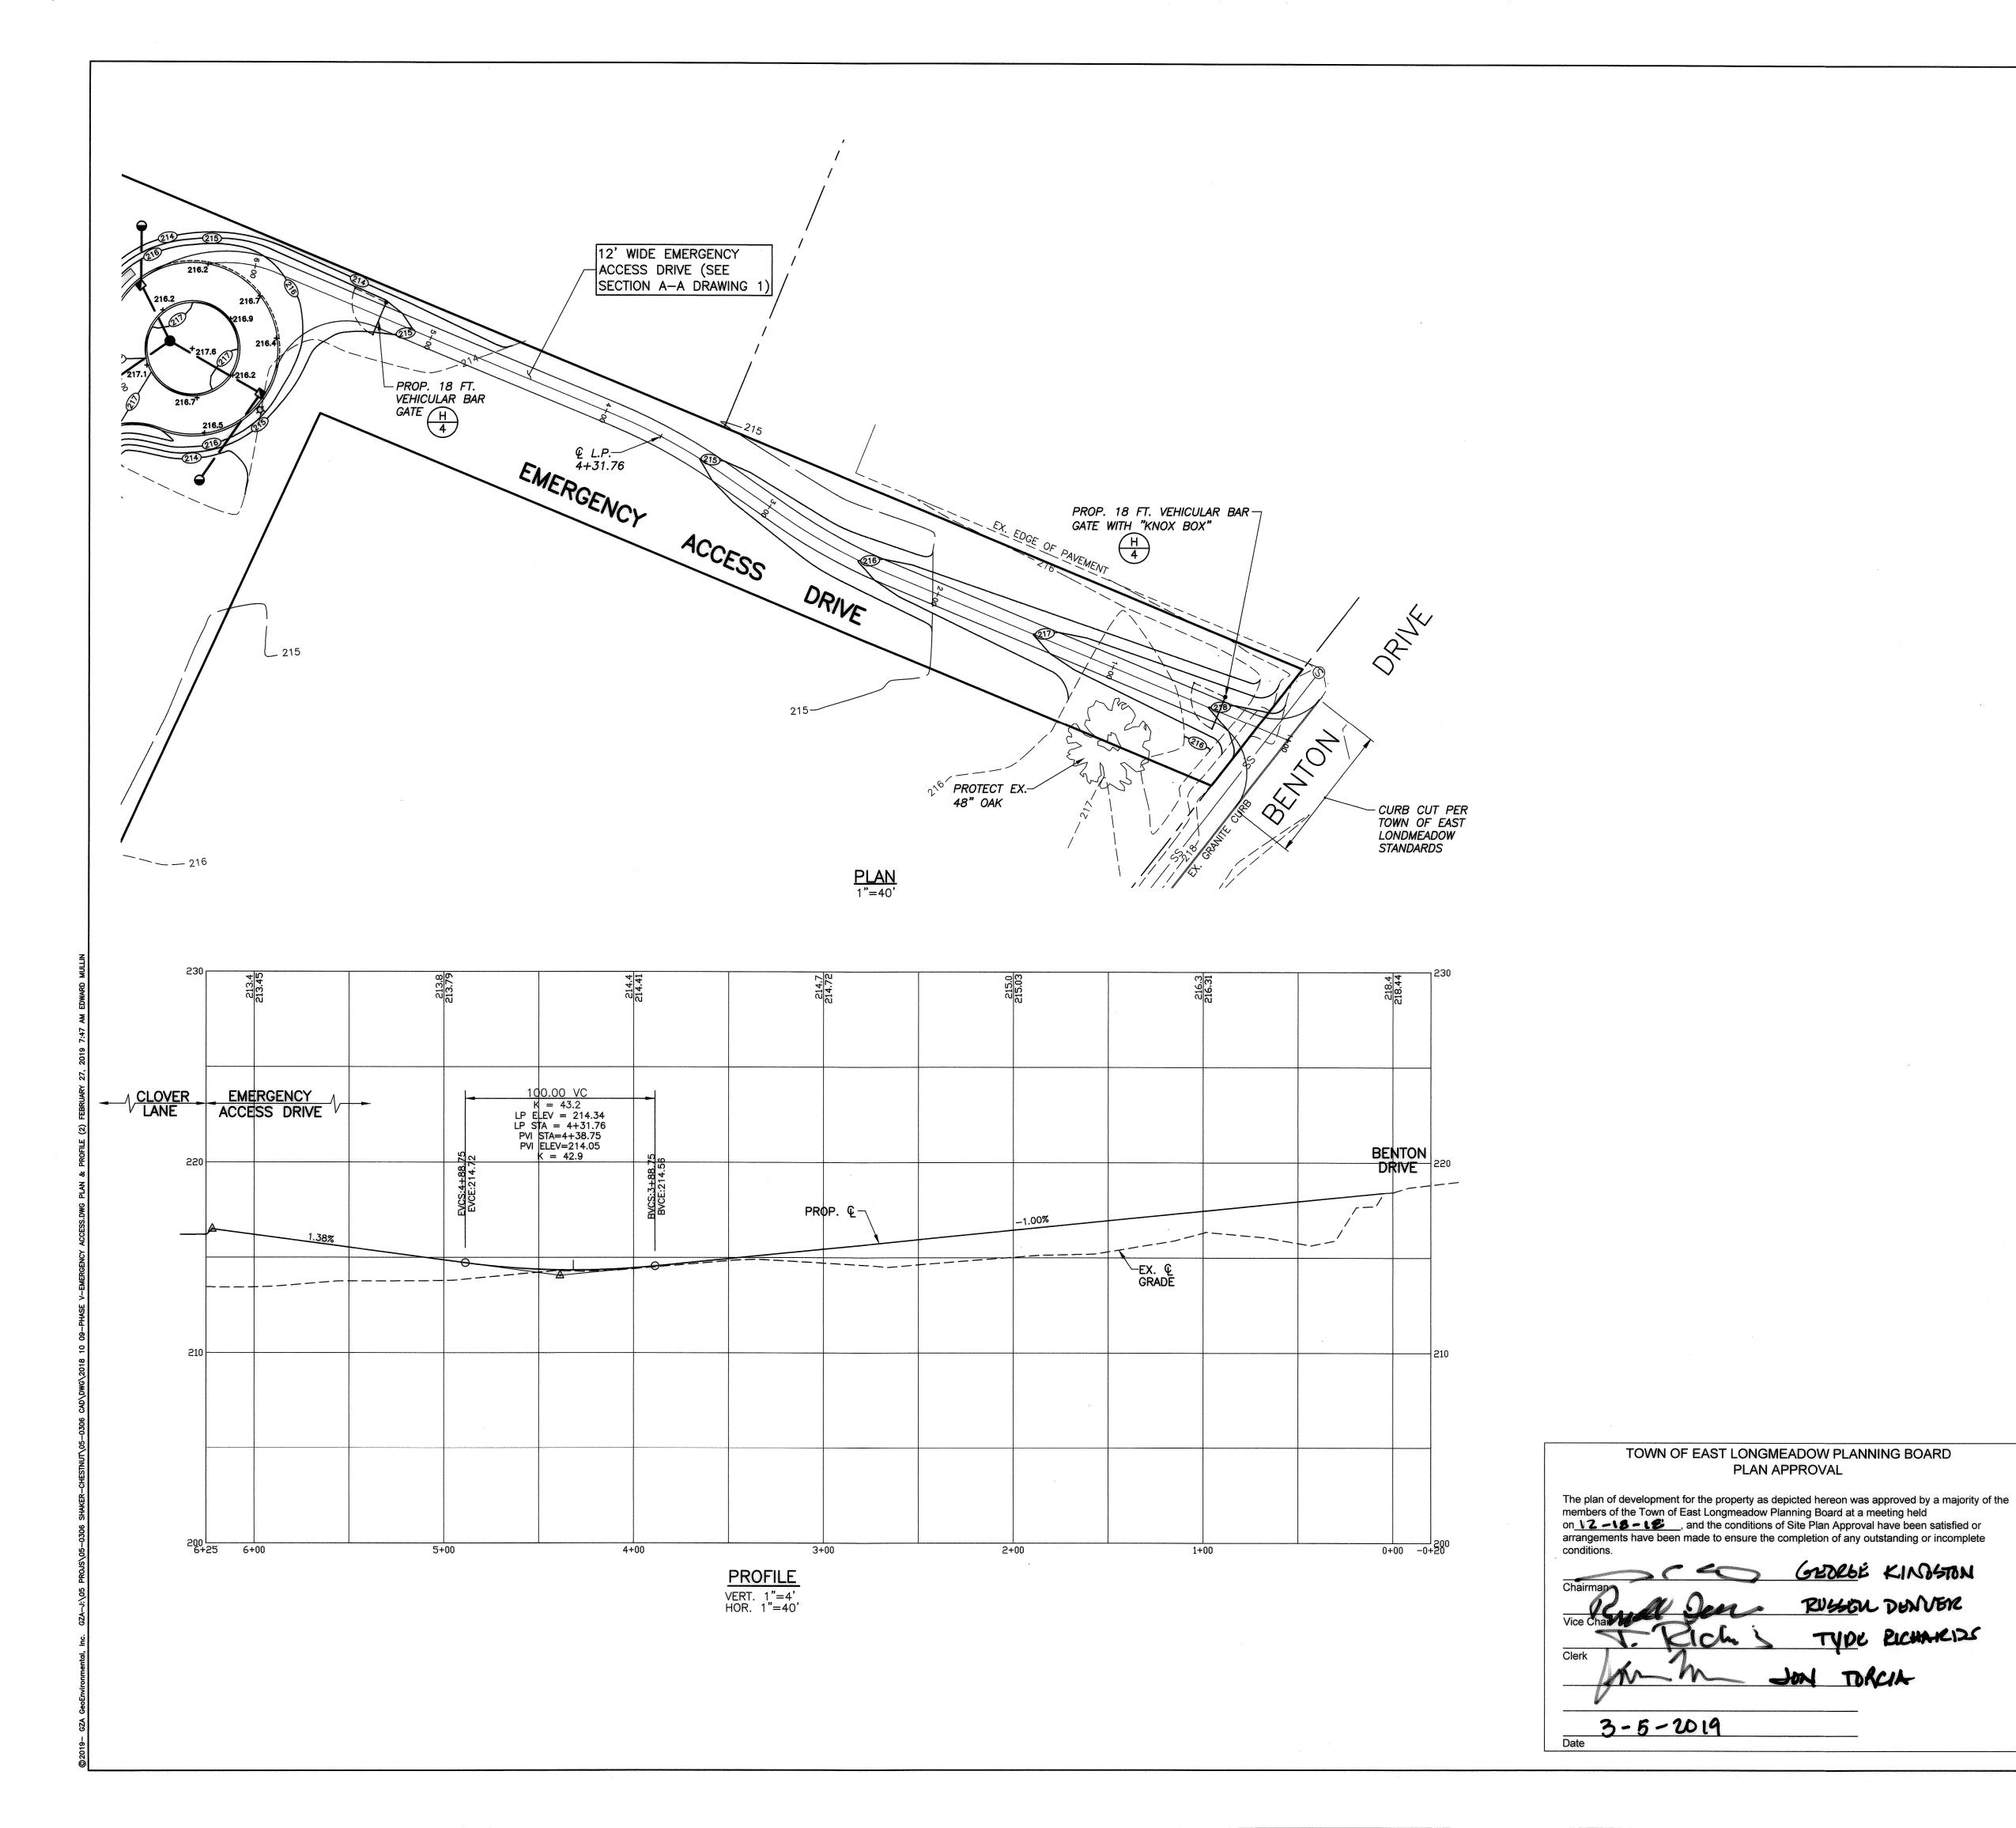

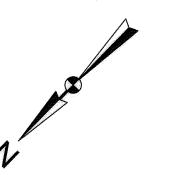


· · · · · · · · · · · · · · · 100 FT. BUFFER \_\_\_\_\_225 \_\_\_\_ EXISTING 5 FT. CONTOURS — — — — — — EXISTING 1 FT. CONTOURS SITE PROPERTY BOUNDARY EXISTING CURB ----- EXISTING EDGE OF PAVEMENT — SD — EXISTING DRAINAGE LINE EXISTING SANITARY SEWER - EXISTING GAS LINE - EXISTING WATER LINE EXISTING CATCH BASIN EXISTING DRAIN MANHOLE EXISTING SANITARY MANHOLE EXISTING UTILITY POLE EXISTING HYDRANT EXISTING WATER VALVE PROPOSED CONTOUR PROPOSED SPOT GRADE PROPOSED CURB —— PROPOSED EDGE OF PAVEMENT PROPOSED STORM DRAIN LINE - PROPOSED SANITARY SEWER - PROPOSED WATER LINE PROPOSED CATCH BASIN B PROPOSED MANHOLE A G 5

PROPOSED HYDRANT J

PROPOSED WATER VALVE

PROPOSED LIGHT POLE (5)

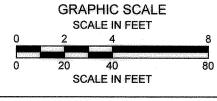

			ж. Бенге сторов « « « « « « « « « « « « « « « « « « «
1	ISSUED TO PLANNING BOARD	EDM	10/27/18
NO.	ISSUE/DESCRIPTION	BY	DATE


GZA GEOENVIRONMENTAL, INC. (GZA). THE INFORMATION SHOWN ON THE DRAWING IS SOLELY FOR USE BY GZA'S CLIENT OR THE CLIENT'S DESIGNATED REPRESENTATIVE FOR THE SPECIFIC PROJECT AND LOCATION IDENTIFIED ON THE DRAWING. THE DRAWING SHALL NOT BE TRANSFERRED, REUSED, COPIED, OR ALTERED IN ANY MANNER FOR USE AT ANY OTHER LOCATION OR FOR ANY OTHER PURPOSE WITHOUT THE PRIOR WRITTEN CONSENT OF GZA. ANY TRANSFER, REUSE, OR MODIFICATION TO THE DRAWING BY THE CLIENT OR OTHERS, WITHOUT THE PRIOR WRITTEN EXPRESS CONSENT OF GZA, WILL BE AT THE USER'S SOLE RISK AND WITHOUT ANY RISK OR LIABILITY TO GZA.

PHASE V-A & V-B THE FIELDS AT CHESTNUT CHESTNUT STREET EAST LONGMEADOW, MA


> **EMERGENCY ACCESS DRIVE PLAN & PROFILE**

STA 0+00 TO 6+25 EPARED FOR: DAN ROULIER & ASSOCIATES

**GZA**GeoEnvironmental of NY 11 SOUTH ROAD Engineers and Scientists SOMERS, CT 06071 www.gza.com TEJ REVIEWED BY: TEJ CHECKED BY: TEJ DRAWING DESIGNED BY: TEJ DRAWN BY: EDM SCALE: 1"=40" REVISION NO. OCTOBER 2018 05-0306 SHEET NO. 3 OF 5

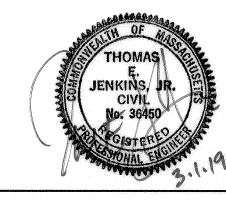

TOWN OF EAST LONGMEADOW PLANNING BOARD PLAN APPROVAL

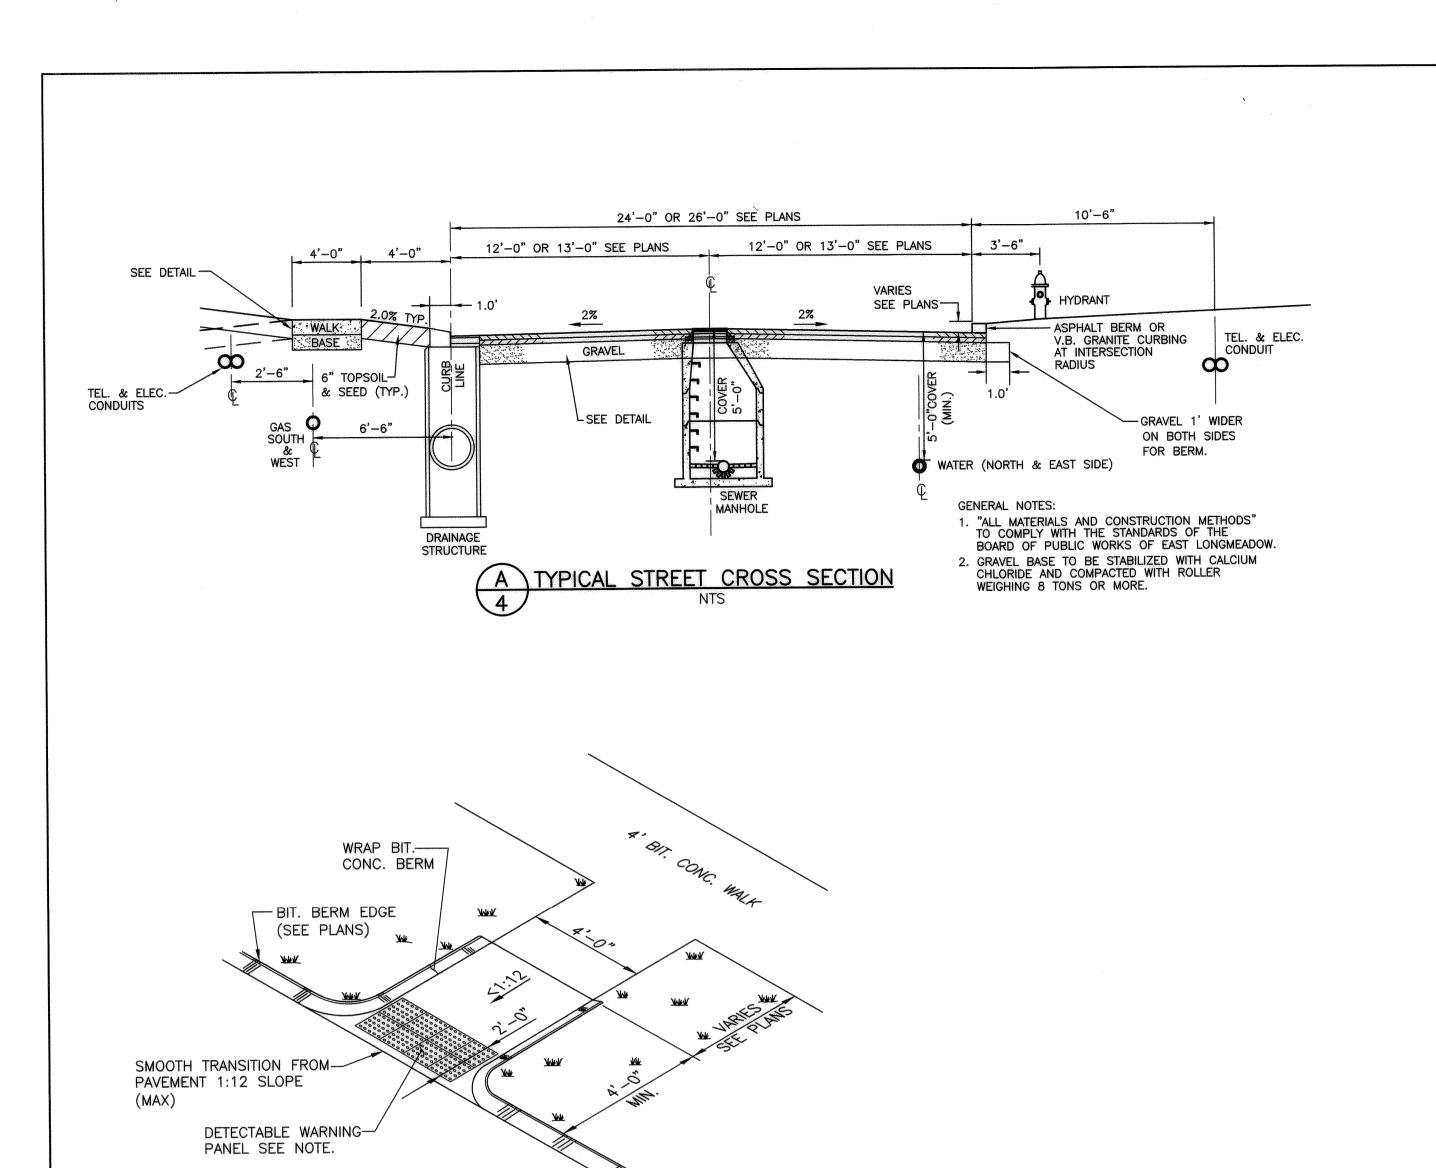

NOTE: DETECTABLE WARNING PANEL SHALL BE

CAST-IN-PLACE COMPOSITE PAVER TILES BY


COLOR SHALL BE "BRICK RED". PANEL SHALL

ADA SOLUTIONS, INC. OR APPROVED EQUAL.

SPAN ENTIRE WIDTH OF CURB RAMP.

RAMP W/ DETECTABLE

WARNING PANEL DETAIL

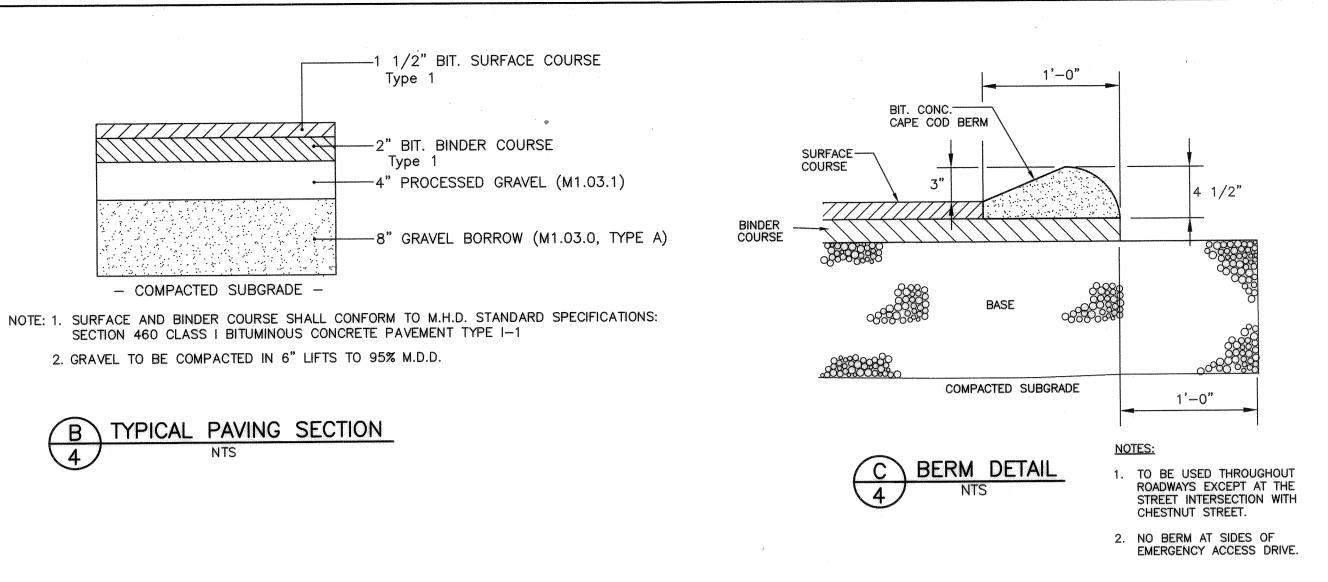

4'-0" -3" SURFACE COURSE IN TWO LIFTS -4" PROCESSED GRAVEL (M1.03.1)-4" GRAVEL BORROW (M1.03.0, TYPE B) - COMPACTED SUBGRADE -

-1 1/2" BIT. SURFACE COURSE

-2" BIT. BINDER COURSE

4" PROCESSED GRAVEL (M1.03.1)

Type 1

Type 1

TYPICAL SECTION D BITUMINOUS CONCRETE WALKWAY


COMPACTED SUBGRADE


B TYPICAL PAVING SECTION


NTS


2. GRAVEL TO BE COMPACTED IN 6" LIFTS TO 95% M.D.D.

SECTION 460 CLASS I BITUMINOUS CONCRETE PAVEMENT TYPE I-1

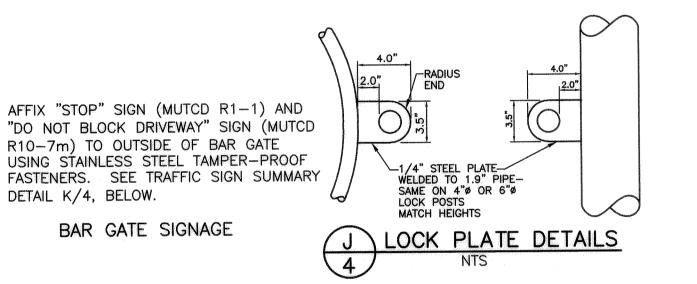

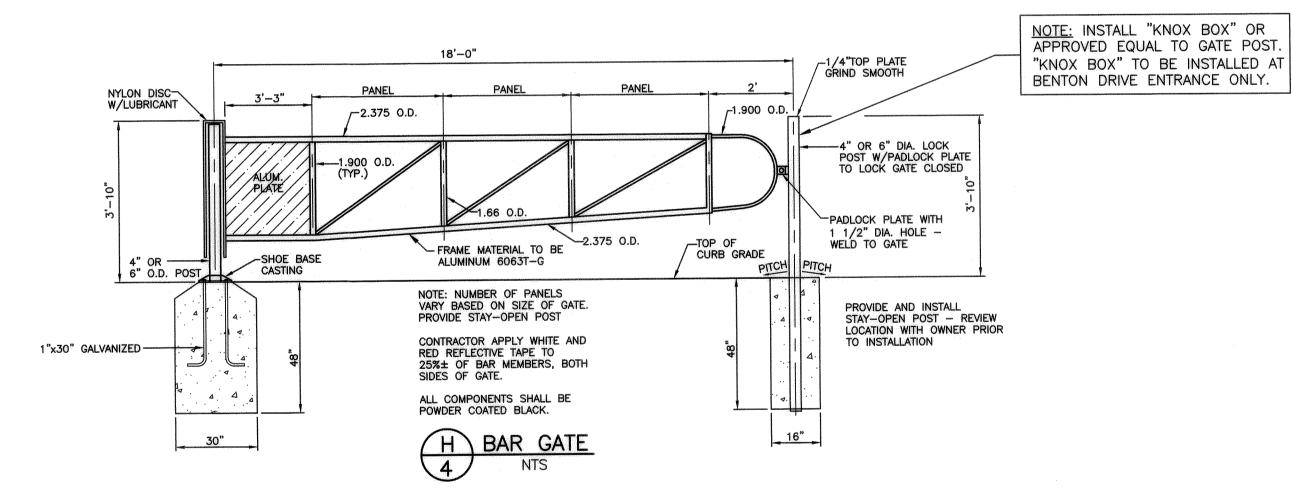


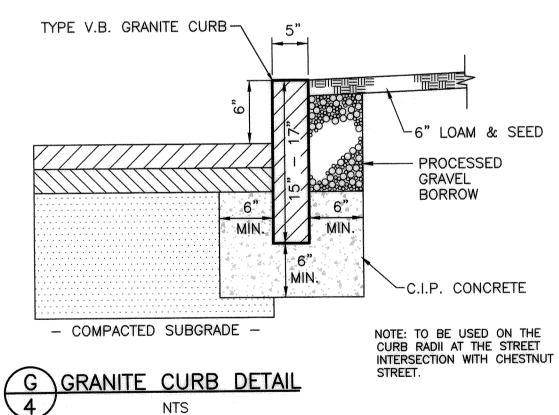

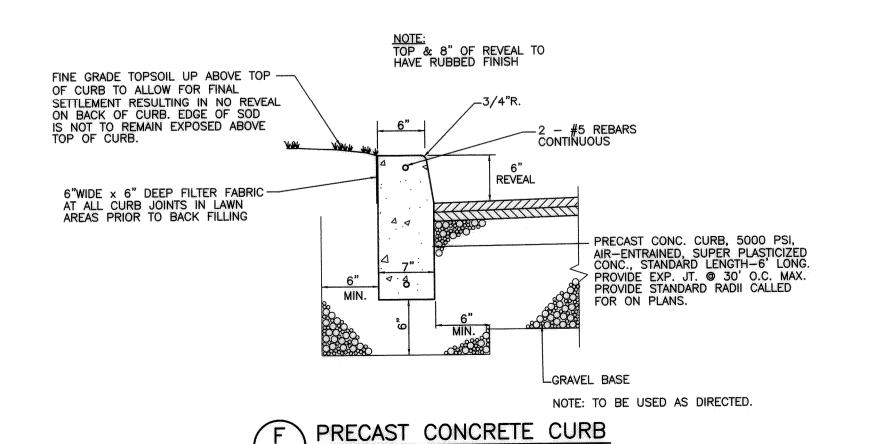

			TRAF	FIC	SIG	N	SUMM	ARY			
IDENTIFI-	SIZE OF SIGN			TEXT DIMENSIONS		NUMBER OF	COLOR		POST SIZE AND		
CATION NUMBER	WIDTH	HEIGHT	TEXT	LETTER HEIGHT	VERTICAL SPACING	ARROW	SIGNS REQUIRED	BACK- GROUND	LEGEND	BURDER	NUMBER REQUIRED
R1-1	30″	30″	STOP	SE	E M.U.T.(	C.D.	6	SE	E M.U.T.	C.D.	P5
R7-S2	12"	18"	NO PARKING FIRE LANE	SE	E M.U.T.	C.D.	24	WHITE	RED	RED	P5

K TRAFFIC SIGNS

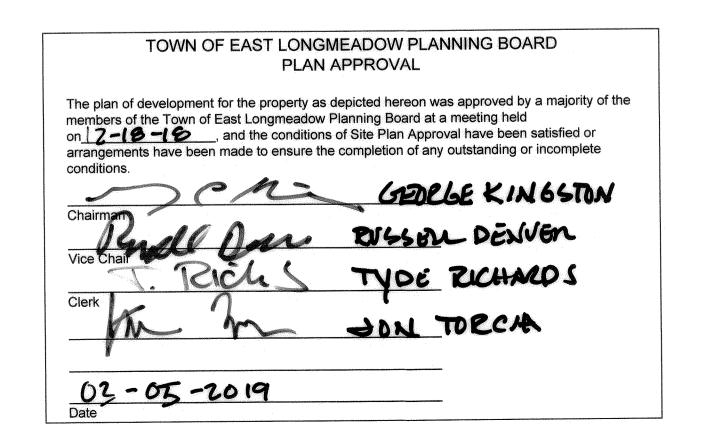

1	ISSUED TO PLANNING BOARD	EDM	10/27/18
NO.	ISSUE/DESCRIPTION	BY	DATE
074	GEOENVIRONMENTAL, INC. (GZA). THE INFORMATION SHOWN ON THE		

PHASE V-B THE FIELDS AT CHESTNUT CHESTNUT STREET EAST LONGMEADOW, MA

GLOVER LANE	& EMERGENCY SITE DETAILS	ACCESS DRIVE

05-0306

	GZAGeoEnv Engineers					
VF	PROJ MGR:	TEJ	RE\			
A.	DESIGNED BY:	TEJ	DRA			
.19	DATE: OCTOBER	2018	PR			

RED BY	<b>GZA</b> Ge	eoEnvironmental of NY leers and Scientists www.gza.com	PREPARED FOR: DAN ROULIER & ASSOCIATES 11 SOUTH ROAD SOMERS, CT 06071		
GR:	TEJ	REVIEWED BY: TEJ	CHECKED BY: TEJ	DRAWING	
ED BY:	TEJ	DRAWN BY: EDM	SCALE: AS NOTED	1	
		PROJECT NO.	REVISION NO.	1 4	

SHEET NO. 4 OF 5

